

GUAM MEMORIAL HOSPITAL AUTHORITY

ATURIDÅT ESPETÅT MIMURIÅT GUÅHÅN

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Amendment #1

GMHA IFB 005-2022

DISPOSAL AND INSTALLATION OF 2 NEW CHILLERS FOR ALTERNATE CARE FACILITY (ACF) AT SKILLED NURSING FACILITY (SNF)

Sincerely,

Item 1. This Amendment issued to replace initial plans with revised plans.

Dolores F. Pangelinan
Hospital Materials Management Administrator

ACKNOWLEDGEME	NT:
COMPANY NAME:	
PRINT NAME:	
SIGNATURE	DATE

	Who see all the second see all the second see all the second see all the second	a constant of the constant of	To be a second	TO ORDINO TO ORDINO	PROJECT LOCATION,	VICINITY MAP	See		PACIFIC	Salar San	SKILLED WIRSING FACILITY, CMHA BARRIGADA, GUAM	Signal and the signal	0 0 0 0 0 0 0 0 0 0 0 0 0 0 0 0 0 0 0	LOCATION MAP					
HORSEY COMEY THAT THIS PLAN WAS RESPANDED BY ME ON HOLDER MY DREET SUPERMOON OATE:	TO NO MACARDA ASSOCIATES INC. TO See See See See See See See See See Se	CIVIL/STRUCTURAL		18 OF 20 E1.0 NOTES & LEGEND 19 OF 20 E2.0 ELECTRICAL POWER PLAN 20 OF 20 E3.0 PARTIAL ONE LINE DIAGRAM	CHANICAL	20 MS.2 PHASE 3 - MECHANICAL ROOM & VARD SOMETRIC PIPING REMOVAL PLAN REMOVAL PLAN	C PIPING REMOVAL PLAN C PIPING PLAN C PIPING PLAN	NG SECTION, PHASE 1 - MECHANICAL ROOM PIPING PLAN, TYPICAL SCHWP PIPING SECTION ON DETAL	BRIEF M, &	OF 20 M1.2 PHASE 1 - MECHANICAL ROOM & MAID REMOVAL FLAW, EXPENDIS, OF 20 M1.2 PHASE 1 - MECHANICAL ROOM & YARD ISOMETRIC P PING REMOVAL PLAN & NOTE OF 20 M2.0 REMOVAL PLAN & NOTE OF 20 M3.0 REMOVAL PLAN & NOTE OF 20	NICAL PIAN FRENCY A PIAN FRENCY	STRUCTURAL NOTES CONCRETE PAD FOUNDATION PLAN AND DETAILS	Z	INDEX OF DRAWINGS		BARRIGAI	SKILLED NUR	GUAM MEMOI	ACF CHILLE
100 E	COLUMN CO	MECHANICAL ELECTRICAL	JPERATURE, DRY-BULB AND WET-BULB. PUMP SUCTION AND DISCHARGE PRESSURES.	AT CHILLED WATER MAINS ARE INSTALLED AND CHILLED WATER PIPING RE-INSULATION INSIDE MECHANICAL ROOM ARE DONE. 9. RECORD THE FOLLOWING AT 4:00 P.M. ON THE DAY OF THE OUTAGE BEFORE A/C SHUTDOWN:	SYSTEM OUTAGE. ASSIST THE GMH MAINTENANCE PERSONNEL TO TURN BACK ON THE SYSTEM WHEN READY. HAVE OMH CONTRACTING OFFICER COORDINATE WITH THE TEMPORARY CHILLER PROVIDER TO TURN THE TEMPORARY CHILLER OFF AND RESTART CHILLER WHEN STUB-OUTS		6. CHEMICAL TREATMENT OF NEW CHILLED WATER AND PURGING OF AIR TROM THE CHILLED WATER SYSTEM WILL BE DONE AFTER RESTARTING THE TEMPORARY CHILLER AND OTHER ARR-CONDITIONING EQUIPMENT. PURGING OF AIR SHALL INCLUDE ALL AHU'S AND ALL FCU'S. 7. WHILE THE AIR-CONDITIONING SYSTEM IS OFF RE-INSULATE ALL CHILLED WATER PIPING IN		S. A/C SYSIEM OUTAGE IS EXPECTED FOR THE FULLOWING WORK, (A) DRAIN CHILLED WATER PIPING UNTIL THE DISCHARGE WATER IS CLEAN. (C) INSTALL AND INSULATE VALVED STUB-OUTS AT EXSTING CHILLED WATER MAINS. (D) REFILL	PREPARE DIMENSIONED INSTALLATION SHOP DRAWING/S FOR REVIEW AND APPROVAL BY GMH'S CONTRACTING OFFICER. A/O CYCTEL OUTLOCK IS EXECUTED FOR THE FOIL DWIND WINDS (A) DRAIN CHILLEN WATER A/O CYCTEL OUTLOCK IS EXECUTED FOR THE FOIL DWIND WINDS (A) DRAIN CHILLEN WATER A/O CYCTEL OUTLOCK IS EXECUTED FOR THE FOIL DWIND WINDS (A) DRAIN CHILLEN WATER A/O CYCTEL OUTLOCK IS EXECUTED FOR THE FOIL DWIND WINDS (A) DRAIN CHILLEN WATER A/O CYCTEL OUTLOOK IS EXCEPTED FOR THE FOIL DWINDS (A) DRAIN CHILLEN WATER A/O CYCTEL OUTLOOK IS EXCEPTED.	 THE AVAILABLE SPACE FOR THIS WORK IS TIGHT, VERIFY ALL EXISTING CONDITIONS, TAKE MEASUREMENT AT SITE AND PREFABRICATE ALL PIPING SYSTEMS AT CONTRACTOR'S FACILITIES AND DELIVER ONLY TO PROJECT SITE WHEN READY FOR INSTALLATION. 		1. TWO WEEKS AFTER AWARD OF CONTRACT, SUBMIT RENOVATION SCHEDULE TO CONTRACTING OFFICER OF GMH FOR APPROVAL. SCHEDULE SHALL INDICATE APPROXIMATE DATES OF UTILITY	RENOVAT		ADA , GUAM	RSING FACILIT	RIAL HOSPITA	ERS No. 1 & 2
ET ME ON WHOSE PLAN WAS PREPARED OATE.			INSTRUCTIONS. OBTAIN MANUFACTURER'S INSTRUCTION THROUGH CONTRACTING OFFICER. COORDINATE WITH AND PROVIDE ASSISTANCE TO THE FACTORY TRAINED TECHNICIAN IN PERFORMING THE ABOVE SERVICES.	(B) STATE UP SERVICES. (C) SYSTEM PERFORMANCE TEST. (D) FIELD ACCEPTANCE TESTING. (NSTALL CHILLER IN ACCORDANCE WITH MANUFACTURER'S PUBLISHED INSTALLATION			STAINLESS STEEL SCREWS. 13. AFTER REMOVAL OF CHILLED WATER FLEXIBLE HOSE, REMOVED MATERIAL COVERING THE DOOR OPENING SO THAT THE MECHANICAL ROOM DOOR CAN BE OPERATIONAL AGAIN. 14. REPAINT THE INTERIOR OF THE MECHANICAL ROOM, FINISH TO MATCH EXISTING, REPAINT	NECESSARY, SHALL BE APPROVED BY THE STRUCTURAL ENGINEER THROUGH THE CONTRACTING OFFICER. WALL OPENINGS THAT WILL NOT BE RE-USED SHALL BE COVERED WITH 18 GAUGE STANLESS STEEL PLATES ON BOTH SIDES OF THE WALL SECURED WITH	TEMPORARY PLYWOOD PARTITION AS NECESSARY. 12. RE-USE EXISTING EXTERIOR WALL OPENINGS RESULTING FROM REMOVAL OF REFRIGERANT PIPING FOR NEW CHILLED WATER PIPING. ENLARGEMENT OF THE WALL OPENINGS, IF	OFFICER AND DOR. 11. SEVERAL EQUIPMENT IN THE MECHANICAL ROOM WILL BE IN USE DURING THE RENOVATION OF THIS PROJECT. EXERCISE EXTREME CARE NOT TO DAMAGE THESE EQUIPMENT. PROVIDE	10. AFTER RESTARTING THE A/C SYSTEM, RECORD THE SAME ITEMS NOTED IN ITEM 9, AT 4:00 P.M. ON THE TJESDAY THE A/C SYSTEM IS RESTARTED. SUBMIT READINGS TO CONTRACTING	PROVIDE AND INSTALL NEW THERMOMETERS AND PRESSURE GAGES TO RECORD THE ABOVE READINGS, PROVIDES COPIES OF THE READINGS TO THE CONTRACTING OFFICER AND THE DOR	(C) CHILLED WATER TEMPERATURE AT SUCTION AND DISCHARGE OF THE OPERATING CHILLED WATER PUMP. (E) VOLTAGE AND AMPERE READING OF THE OPERATING CHWP.	RENOVATION NOTES			≺		
T1.0	Date: 10/27/2021 Project No. AutoCAD File 61K2111 am Art causes Drawing No.	Supv: ASC	Drawn: KPC Checked: ASC	Designed: ruch	Title: LOCATION MAP, VICINITY MAP, INDEX OF DRAWNGS, & CONSTRUCTION NOTES	BARRIGADA, GUAM	ACF CHILLERS GMH SKILLED NURSING FACILITY				DATE 11 01 200	BY ME OR HOUSEN MY DRECT SUPERVISION	OLCONO AL DELEGA	A Company of the Comp	MECHANICAL, IV.C. LUS-A-NORTH VERBE JR.V. LUS-A-NORTH JR.				No. Description Date

STRUCTURAL NOTES (REFERENCE AS IT APPLIES)

GENERAL NOTES

- GENERAL NOTES AND TYPICAL STRUCTURAL DETAILS SHALL APPLY TO ALL DRAWINGS UNLESS OTHERWISE SHOWN OR NOTED. FEATURES OF RENOVATION SHOWN ARE TYPICAL AND SHALL APPLY GENERALLY THROUGHOUT FOR SIMILAR CONDITIONS.
- THE CONTRACTOR SHALL EXAMINE THE DRAWINGS AND SHALL NOTIFY THE 2. ENGINEER/ARCHITECT OF ANY DISCREPANCIES HE MAY FIND BEFORE PROCEEDING WITH THE WORK OR DURING CONSTRUCTION.

 THE CONTRACTOR WILL BE RESPONSIBLE FOR COORDINATING THE WORK AMONG THE WAROUS TRADES AS NECESSARY TO AVOID CONFLICT AND TO ENSURE THE INSTALLATION OF ALL WORK WITHIN THE AVAILABLE SPACE.
- IT SHALL BE THE CONTRACTORS RESPONSIBILITY TO PROVIDE ADEQUATE SHORING AND BRACING OF THE STRUCTURE FOR ALL LOADS THAT MAY BE IMPOSED DURING CONSTRUCTION. ALL MATERIALS AND WORKMANSHIP SHALL CONFORM WITH THE LATEST APPLICABLE STANDARDS OR SPECIFICATIONS.
- DO NOT SCALE DRAWINGS, CALLED-OUT DIMENSIONS AND STANDARD CODE REQUIREMEDIAT SHALL GOVERN OVER UNSCALED DRAWINGS.

FORMWORK

- -FORMS SHALL BE PROVIDED FOR ALL CONCRETE INDICATED UNLESS SPECIFIED OTHERWISE FORMS SHALL BE SET TRUE TO LINE AND GRADE AND MAINTAINED SO AS TO ENSURE COMPLETED WORK WITHIN THE ALLOWABLE TOLERANCES SPECIFIED AND SHALL BE MORTAR TIGHT.
- FORMS AND THEIR SUPPORTS SHALL BE DESIGNED SO AS NOT TO DAMAGE PREVIOUSLY PLACES STRUCTURE.
- Ļ NO CONSTRUCTION LOAD SHALL BE SUPPORTED ON, NOR ANY SHORING REMOVED FROM ANY PART OF STRUCTURE UNDER REMOVATION EXCEPT WHEN THING PORTION OF THE STRUCTURE IN CONSUMENTION WITH THE THE REMAINING FORMIOS AND SHORING/BRACING SYSTEM HAS SUFFICIENT STRENGTH TO SUPPORT SAFELY ITS WEIGHT AND THE ADDITIONAL IMPOSED LOADS.
- Forms shall be removed in such manner as not to impair safety and serviceability of the structure.

REINFORCING STEEL

- 1. ALL REINFORCING BARS SHALL CONFORM TO BASIC DESIGN CRITERIA.
- ANY WELDING TO BE PERFORMED MUST HAVE PRIOR WRITTEN APPROVAL OF THE ENGINEER.
- WELDING OF REINFORCING STEEL IS NOT PERMITTED UNLESS OTHERWISE SHOWN ON THE DRAWINGS. WELDING OF REINFORCING STEEL STALL CONFORM TO AME D1.4-79 AWS STRUCTURAL WELDING CODE REINFORCING STEEL OF THE AMERICAN WELDING SOCIETY. REINFORCING STEEL WHICH IS WELDED SHALL CONFORM TO ASTM A 706. REINFORCING STEEL NOT CONFORMING TO ASTM A706 MAY BE USED IF MATERIAL PROPERTIES OF THE REINFORCING STEEL CONFORM TO ASTM A706 MAY BUSED IF MATERIAL PROPERTIES OF THE REINFORCING STEEL CONFORM TO AWS D1.4-79.
- REINFORCING BARS SHALL BE SPLICED 42d (d= BAR DIAMETER) ONLY AS INDICATED ON THE DRAWINGS.
- PROVIDE DOWELS IN FOOTINGS AND/OR GRADE BEAMS THE SAME SIZE AND SPACING AS COLUMN AND WALL REINFORCING, UNLESS OTHERWISE NOTED.
- WELDED WIRE FABRIC (WWF) SHALL CONFORM TO ASTM A-185. WELDED WIRE FABRIC IN SUSPENDED SLABS SHALL HAVE FY = 80 KSI. LAP 12" MINIMUM OR TWO FULL MESH, WHICHEVER IS GREATER FOR SLABS ON GRADE.
- MINIMUM CONCRETE COVER FOR REINFORCING BARS SHALL BE:
 CONCRETE CAST AGAINST EARTH
 EXPOSED TO EXTERIOR OR MEATHER
 #6 BAR THROUGH #18 BAR
 #5 BAR, W31 OR D31 WIRE, AND SMALLER SIAB ON GRADE
 COLUMNS & BEAMS
 STRUCTURAL SLABS TOP & BOT. (INTERIOR) ... 1 1/2" ... 1 1/2" & 3/4" ٧, 1 1/2
- IN GENERAL BAR SPLICES SHALL BE MADE AT POINTS OF MINIMUM STRESS. SPLICES SHALL BE SECURELY WIRED TOGETHER. STAGGER SPLICES AT LEAST 24" WHENEVER POSSIBLE IN BEAMS AND SLABS. SPLICE TOP BARS AT MIDSPAN AND BOTTOM BARS MARK SUPPORT. SPLICE OF RENFORCEMENT SHALL BE MADE ONLY AS REQUIRED OR PERMITTED ON DESIGN DRAWINGS OR AS ALLOWED BY THE ACCODE OR AS AUTHORIZED BY THE ENGINEER.
- ANCHOR BOLTS, DOWELS AND OTHER EMBEDDED ITEMS ARE TO BE SECURELY TIED IN PLACE BEFORE CONCRETE IS POURED.
- ĕ ALL REINFORCING BAR BENDS SHALL BE COLD BENT PER ACI 315.
- SHOP DRAWNICS: THE CONTRACTOR SHALL SUBMIT SHOP DRAWNICS FOR REINFORCING STEEL PREPARED IN ACCORDANCE WITH ACI 315. INDICATE BENDING DIAGRAM, ASSELBITY DIAGRAM, SPLICING AND LAPS OF RODS AND SHAPES DIMENSIONS AND DETAILS FOR REINFORCING BARS.

REINFORCED CONCRETE NOTES

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REVISIONS

Description

Date

- ALL CONCRETE SHALL DEVELOP A MINIMUM ULTIMATE COMPRESSIVE STRENGTH AT THE END OF 28 DAYS, AS SPECIFIED UNDER BASIC DESIGN CRITERA.
 ALL CONCRETE WORK SHALL CONFORM TO THE LATEST CODE OF THE AMERICAN CONCRETE INSTITUTE (ACI 318–05).
- LOCATION OF ALL CONSTRUCTION OR CONTRACTION JOINTS MUST BE APPROVED BY THE ENGINEER/ARCHITECT.
- PIPES OR DUCTS EXCEEDING ONE THIRD OF THE SLAB OR WALL THICKNESS SHALL NOT BE PLACED IN STRUCTURAL CONCRETE UNLESS SPECIFICALLY DETAILED.
- REINFORCING BARS, ANCHOR BOLTS, AND OTHER INSERTS SHALL BE SECURED IN PLACE BEFORE POURING. CONCRETE BAR PLACEMENT AND SUPPORTS SHALLBE IN ACCORDANCE WITH THE RECOMMENDED ACI PRACTICE.
- ALL INSERTS, ANCHOR BOLTS, PLATES, ETC. TO BE EMBEDDED IN CONCRETE SHALL BE HOT DIP GALVANIZED UNLESS OTHERWISE NOTED.
- IN GENERAL, THE LATEST EDITION OF "MANUAL OF STANDARD PRACTICE FOR DETAILING CONCRETE STRUCTURES" ACI 315, SHALL BE ADHERED.
- USE OF ADMIXTURE IS PERMITTED TO PRODUCE PROPER SLUMP AND WORKABILITY BUT SUBJECT TO THE ENGINEER'S APPROVAL ADDITION OF WATER TO CONCRETE AT JOBSITE IS NOT ALLOWED.
- 48 HOURS PRIOR TO THE PLACEMENT OF ANY STRUCTURAL CONCRETE THE CONTRACTOR SHALL NOTIFY THE ENGINEER SO AN INSPECTION CAN BE MADE ON ALL FORMS AND REINFORCING.

BASIC DESIGN CRITERIA

CODES AND REFERENCES

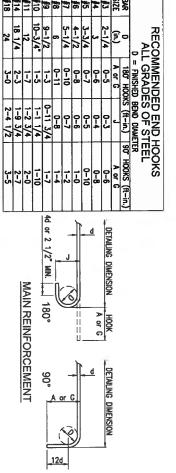
- IBC-2009 INTERNATIONAL BUILDING CODE
- ASCE 7-05 MINIMUM DESIGN LOAD FOR BUILDING & STRUCTURES
- 3. ACI 318-09 BUILDING CODE REQUIREMENTS FOR REINF. CONCRETE

LOADING

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B.) IMPURIANCE FACIOR le = 1.25	A) AS PER ASCE 7-05 RISK CATEGORY III	3. SEISMIC RISK ZONE 4 REQUIREMENT	B.) VELOCITY PRESSURE qh = 54 psf	A.) BASIC WIND SPEED V = 170 mp	WIND LOAD	A.) CONCRETE ACTUAL	DEAD LOAD
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MATERIAL STRESSES

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#5 AND	₽4 AND	REINFORCING	 CAST-IN-PLACE CONCRETE
LARGER	SMALLER	BARS	CE CONCRETE
\$5 AND LARGER GRADE 60	#4 AND SWALLER GRADE 40	2. REINFORCING BARS ASTM A615	fc' = 3,000 psi
GRADE	GRADE	ASTIM	ਨੂੰ ॥
8	8	A615	3,000 psi



STIRRUP (TIES SIMILAR) STIRRUP/TIE HOOK DIMENSIONS ALL GRADES OF STEEL D 135 HOKS (in.) 907 HOOKS (ft-in.) (in.) LOOK OK DIMENSIONS (in.) HOOK OK		ä	7	6	5	-	G	Æ	€			1
RRUP (TIES SIMILAR) 7/TIE HOOK DIMENSIONS GRADES OF STEEL 135 HOOKS (II.) 135 HOOKS (II.) 137 HOOKS (II.) 137 HOOKS (II.) 138 HOOKS (II.) 137 HOOKS (II.) 138 HOOKS (II.) 138 HOOKS (II.) 139 HOOKS (II.) 130		.	5-1/4	4-1/2	2-1/2	2	1-1/2	(Ē)	0	AL	STIRRU	2
S SIMILAR) S DIMENSIONS OF STEEL (in) 90 HOOK PROX A OF 6 1-4 3 O-4 1/2 1-0 DETAILING DIMENSION BEAM 90° BEAM 135°		10-1/2	9	8	5-1/2	4-1/2	4	A PROOK		L GRADE	PTIE K	D
ONS		6	5-1/4	4-1/2	3-3/4	L	2 1/2	(APPROX.)	OKS (in.)	S OF ST		EC CIM
A or G BEAM 90° DETAILING DIMENSION HOOK A or G BEAM 135°		ī	1-2	1-6	0-6	0-4 1/2	₽	> 9 € E	I —	LEEL .	ENSIONS	100
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SCALE:	TYP.
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	& BEND
N.T.S	DETAIL

STIRRUPS AND HOOKS DETAIL

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NOTE: NOT MOR SHALL BI REQUIRED	1 9	-88	# 7	o de la companya de l	15	14	U	BAR SIZE	TABLE C
E THAN 50 E SPLICED LAP LENG	&	42"	37"	32"	27"	24"	24"	LENGTH TYPE A	OF LAP SPL HORAGE LE
)% OF THE BARS WITHIN THE STH	1'-6"	1'-4"	1'-2"	1'-0"	0'-10"	0'-8"	0'-6"	ANCHORAGE LENGTH Ldh	ICE AND

SPLICE & ANCHORAGE TABLE



MECHANICAL, INC.
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HEREBY CERTIFY THAT THIS PLAN WAS PREPARED BY ME OR UNDER MY DIRECT SUPERVISION

N.C. MACARIO & ASSOCIATES, INC. P.O. Box 784 Agona, Guern 98910 Tel. 646-0947/48 Fox: 646-0901 Email: ncma@guam.net

ACF CHILLERS
GMH SKILLED NURSING
FACILITY

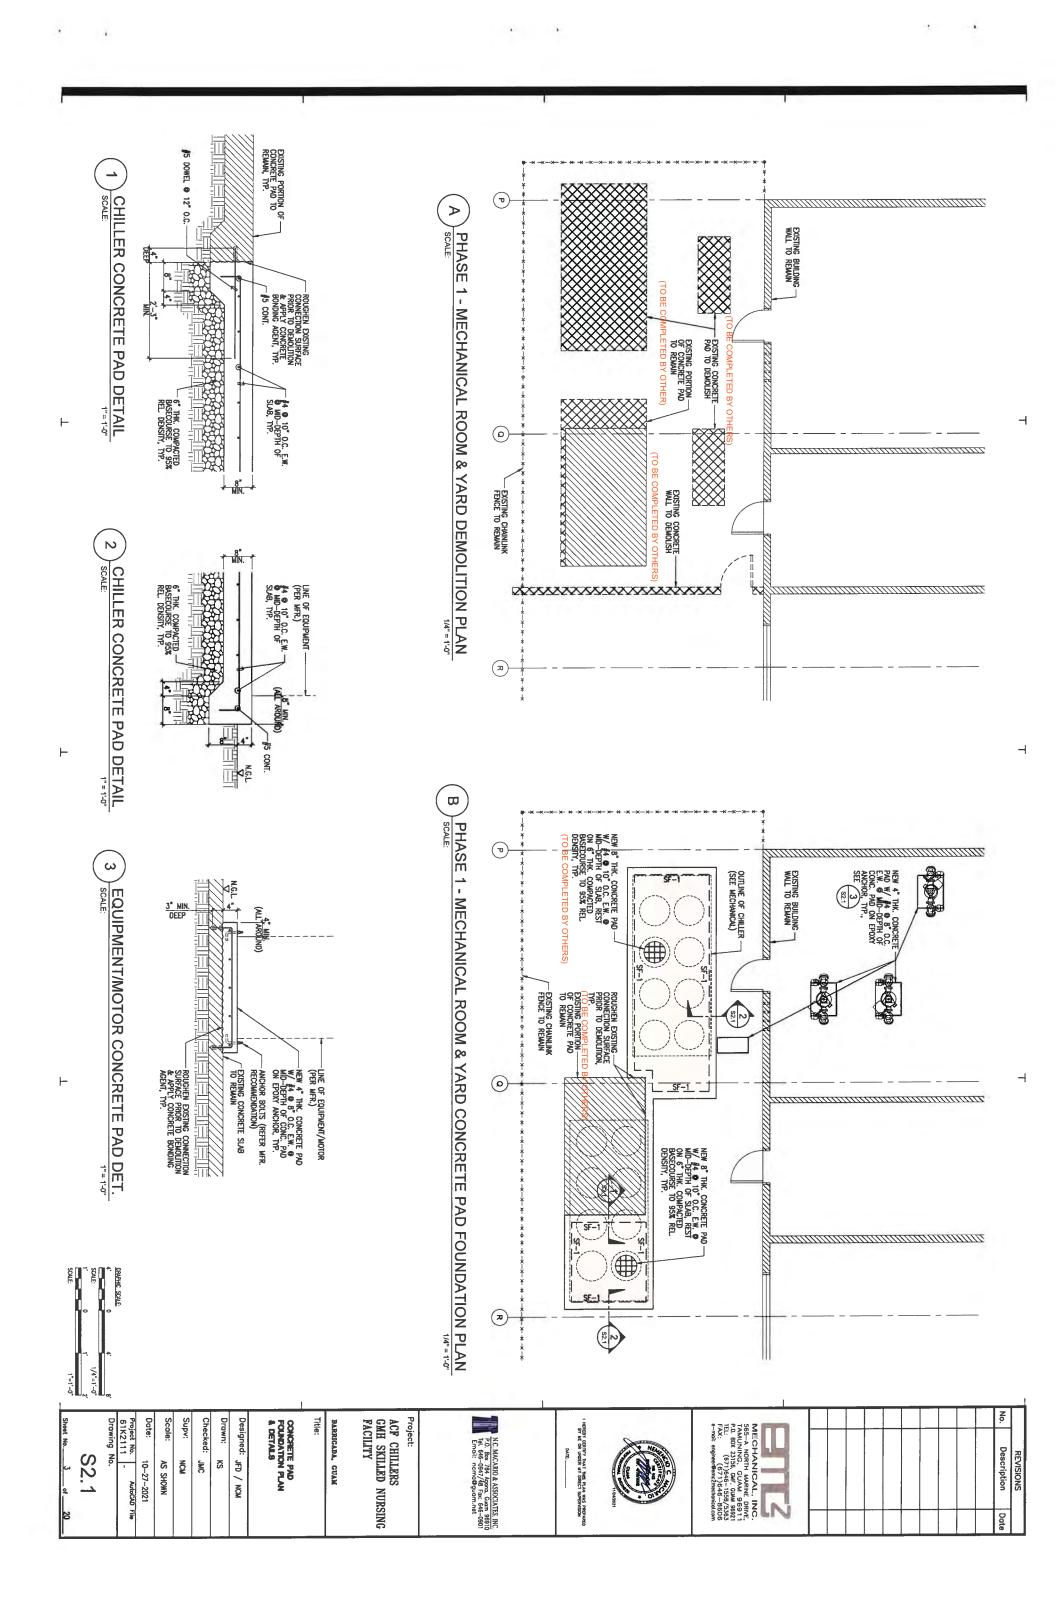
BARRIGADA, GUAM

STRUCTURAL NOTES

Designed: JFD / NCM

Checked: S NCM K 10-27-2021 NAOHS SY AutoCAD File

S1.1



AIR-COOLED CONDENSERS ON CONCRETE PAD 1) SCALE: 1/32"=1'-0" OSIO: 20' 40' 80' SCALE: 1/32"=1'-0" PUMP LIFT STATION 4"CW, 6"SPKR, &
4" TO FIRE
DEPARTMENT
CONNECTION (UG) — LPG ENCLOSURE LPG TANKS RM. - FLEXIBLE HOSE TO & FROM EXISTING CHILLER PIPING TEMPORARY AIR-COOLED CHILLER 6"CW 51,000 GAL. STO. CAP.
UNDERGROUND WATER STO. TANK FIRE DEPARTMENT CONNECTION NOTE:
FIELD VERIFY EXISTING CONDITIONS TO ACCOUNT
FOR CHANGES, EXPECTED OR OTHERWISE.

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Project No. AutoCAD File 61K2111 can AF DILLDS

ASC AS SHOWN 10/27/2021

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Project:
ACF CHILLERS
GMH SKILLED NURSING
FACILITY

BARRIGADA, GUAM

Title:
EXISTING MECHANICAL SITE
PLAN

Designed: EMC2

Drown: KPC

Checked: ASC

No. Description Date

No. Description Date

Description Date

No. Description Date

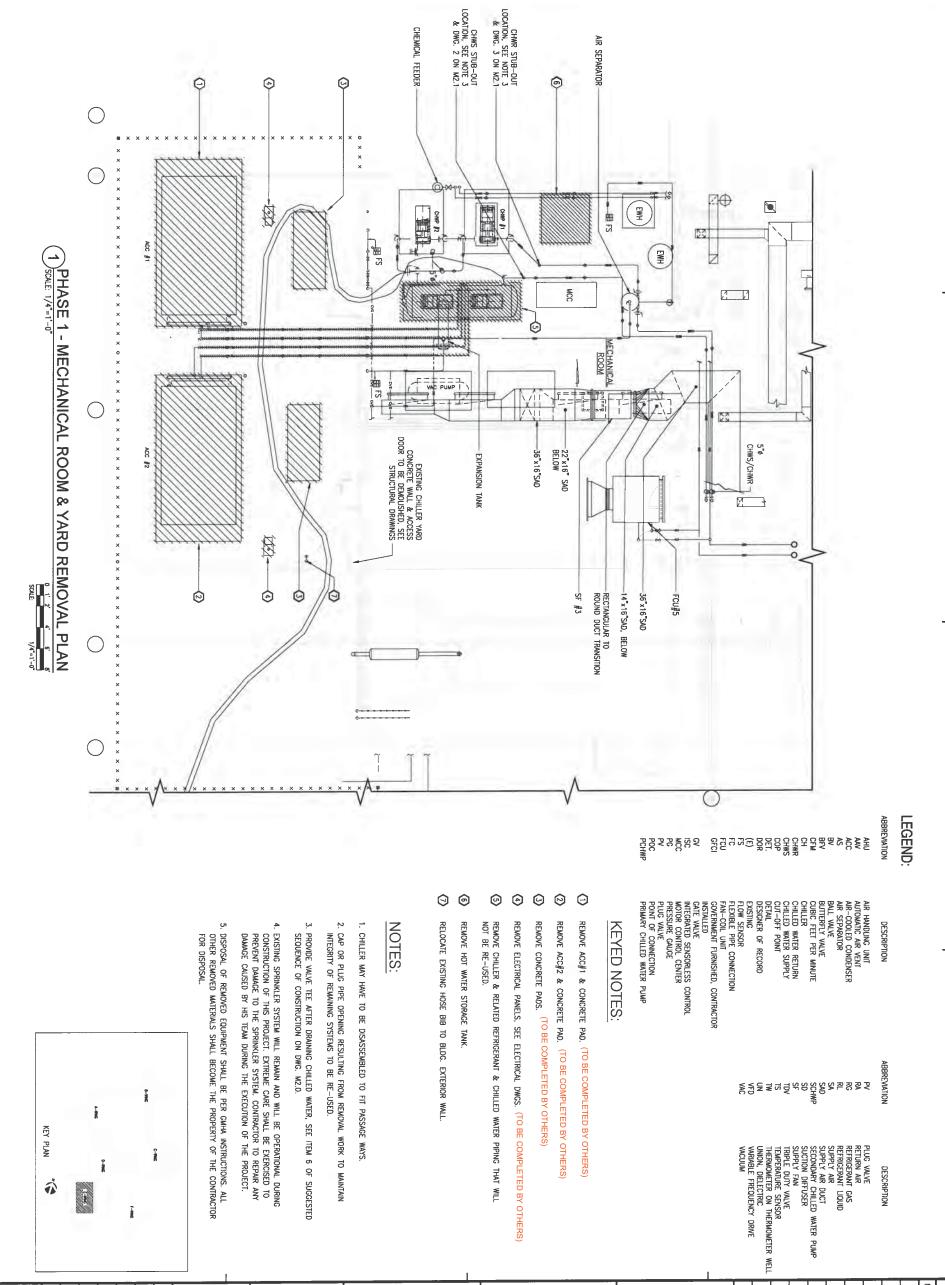
Description Date

Description Date

Description Date

Description Date

No. Description Date



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e-mail: engineer@emc2mechanical.com

Description

Date

REVISIONS

ACF CHILLERS
GMH SKILLED NURSING
FACILITY Project:

PHASE 1 - MECHANICAL ROOM & YARD REMOVAL PLAN, LEGEND, KEYED NOTES & NOTES BARRIGADA, GUAM

Designed: EMC2 Drawn: Checked: Date: Supv: KPC ASC 10/27/2021 AS SHOWN ASC

M1.1

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AutoCAD File

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1) PHASE 1 - MECHANICAL ROOM & YARD ISOMETRIC PIPING REMOVAL PLAN NOTE: WHEN REMOVING CHILLER, VALVE. PROVIDE GASKETED REMOVE CHW PIPING FROM CHILLER TO ISOLATION BLIND FLANGE AT BFV. ACF CHILLERS
GMH SKILLED NURSING
FACILITY Designed: EMC2 PHASE 1 - MECHANICAL ROOM & YARD ISOMETRIC REMOVAL PLAN & NOTE Project: Checked: 565—A NORTH MARINE DRIVE,
TAMUNING, GUAM 96911
P.O. 80X 23156, GUF, GUM 96921
TEL: (67)9646—1558/5353
FAX: (67)9646—1606
e-mail: engineer@emc2mechanical.com Supv: BARRIGADA, GUAM HEREBY CERTIFY THAT THIS PLAN WAS PREPARED BY ME OR UNDER MY DIRECT SUPERVISION REVISIONS Description M1.2 DATE: 11 03.2021 KPC ASC ASC 10/27/2021 NWOHS SA AutoCAD File

Date

EQUIPMENT SCHEDULE:

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AIR COOLED CHILLER (GFCI):

		<u> </u>	_	
CH#2	CH#1		MARK	
134.1	134.1	(TON)	CAPACITY	NE SE
268	268	(GPM)	WATER	
54	54	WATER (F)	ਨੈ	COL
42	42	WATER (°F)	LEAVING	COOLER DATA
10	10	MAX(FT)	PRESSURE	TA
0.00010	0.00010	FACTOR (h-ft2-F/Btu)		
18.34	18.34		IPLV.IP	
R410A	R410A		REFRIGERANT	
95	95	L. CONDENSER	ENTERING	AIR TEMP.
2	2	OROJIS	PARTED PARTE	5
8	ca	FANS	CONDENSER	5
269	269	MCA	POWE	2
350	350	CA MOCP VOLTS PHASE HER	POWER SUPPLY CHARACIERISI	
460	460	VOLTS	TT CHAI	
3	J.	PHASE	ו לאכוניגו	T CTT
60	60	HERTZ	College	5
CHILLER AND POSITION ON CONCRETE PAD.	CHILLER WILL BE DELIVERED TO PROJECT SITE BY		REMARKS	

NOTE: 1. CONTRACTOR TO VERIFY EXISTING POWER REQUIREMENT OF UNIT BEFORE ORDERING EQUIPMENT.

CHILLED WATER PUMPS:

SCHWP#3	SCHWP#2	SCHWP#1	PCHWP#3	PCHWP#2	PCHWP#1	MARK	
FUTURE DOAS	STAND-BY	EXISTING AHU'S & FCU'S	CHILLER NO. 2	STAND-8Y	CHILLER NO. 1	SERVING	
268	268	268	268	268	268	GPM	CAPACITY
100	100	100	40	40	40	귀	Į
3,600 3"	3,600	3,600	1,800	1,800	1,800	RPM	WOTON.
3"	J.	3"	4.	4,	4,	SZE (IN)	SUCTION
3"	3	3"	4"	4.	4.	SZE (IN)	250 ASC
73%	73%	73%	75%	75%	75%	RPM SZE (IN) SZE (IN) EFFICIENCY, MIN.	INIOA ALITU EXBACISTO NOLLOTE BULLUM
IN-LINE CENTRIFUGAL PUMP, VERTICAL MOUNTING	IN-LINE CENTRIFUGAL PUMP, VERTICAL MOUNTING	IN-LINE CENTRIFUGAL PUMP, VERTICAL MOUNTING	IN-LINE CENTRIFUGAL PUMP, VERTICAL MOUNTING	IN-LINE CENTRIFÜGÄL PUMP, VERTICAL MOUNTING	IN-LINE CENTRIFUGAL PUMP, VERTICAL MOUNTING	ЗЧТ	
15	15	15	5	5	G	₩,	QOTON.
460	460	460	460	460	460	YOLI	5
3	3	3	3	3	Ç.	PHASE	AIDDIS GAMUD
60	60	60	50	60	60	HERTZ	7
	CONTROLLER.	PROVIDE EACH PUMP WITH VARIABLE FREQUENCY DRIVE & PUMP MOUNTED PARALLEL SENSORLESS	DUTY MOTOR.	PROVIDE PUMPS CONSTRUCTED OF STAINLESS STEEL FITTED MATERIALS, IN-LINE PIPING		REMARKS	

SUGGESTED SEQUENCE OF RENOVATION

NOTE: THE EXISTING FACILITY IS TEMPORARILY AIR-CONDITIONED L SHALL BE SEQUENCED TO MINIMIZE A/C SYSTEM DOWNTIME. -CONDITIONED USING A RENTAL CHILLER. WORK

- REMOVE REFRIGERANT PIPING BETWEEN CONDENSERS & CHILLERS.
- REMOVE AIR-COOLED CONDENSERS AND CONCRETE PADS AT MECHANICAL YARD.
- REMOVE CHILLER AND CONCRETE PAD.
- REMOVE ABANDONED HOT WATER STORAGE TANK.
- FILL CHILLED WATER LINES & CHEMICALLY TREAT NEW CHILLED WATER USING EXISTING CHE DRAIN CHILLED WATER LINES. PROVIDE VALVED STUB-OUTS AT EXISTING CHILLED WATER PIP CONSTRUCT CONCRETE PADS FOR CHILLERS & PUMPS.
- FEEDER. PURGE AIR FROM THE CHILLED WATER LINE.
- RESTART TEMPORARY CHILLER & ONE CHWP TO REACTIVATE AIR CONDITIONING SYSTEM.
- INSTALL PCHWP#1, SCHWP#1 & #2, & CHILLER#1 & #2, ISOLATE TEMPORARY CHILLER.
- THE NEW VALVED STUB-OUTS.
- TEST RUN CHILLER#1 WITH PCHWP#1 AND SCHWP#1. AFTER A SUCCESSFUL TEST REMOVE INSTALL NEW CHILLED WATER PIPING UP TO
- CHWP#2 AND CONCRETE PAD. INSTALL PCHWP#2 WITH NEW CONCRETE PAD. TEST RUN CHILLER#1 WITH PCHWP#2 AND S TEMPORARY CHILLER IS READY TO BE REMOVED. SCHWP#2. AFTER SUCCESSFUL TESTING, INFORM
- 14. REMOVE EXISTING CHWP#1 & EXISTING PIPING UP TO NEW TEE STUB-OUTS. PROVIDE GASH 13. COORDINATE WITH TEMPORARY CHILLER SYSTEM PROVIDER ALL WORKS AND ASSEMBLIES DU SEQUENCE. ANY REQUIRED OUTAGES IN SERVICES SHOULD BE LIMITED IN SCHEDULE.
- 15. INSTALL PCHWP#3, SCHWP#3 & CHILLER #2 CHILLED WATER RETURN PIPING. FLANGE AT OPEN END OF BVS.
- TEST RUN CHILLER#2 WITH PCHWP#3 & SCHWP#3.

NOTES:

FOR PCHWP#3, PROVIDE 4" VALVED STUB-OUT ONLY AT CHWR HEADER.

BFV AT RISER

CHWR FROM FUTURE CHWR EXIST'G AHU'S & FROM DOAS FCU'S

CHWS TO EXIST'G AHU'S & FCU'S

- FOR CHWR FROM DOAS, PROVIDE 4" VALVED STUB-OUT ONLY AT CHWR HEADER.
- FOR SCHWP#3, PROVIDE 4" VALVED STUB-OUT ONLY AT CHWS HEADER.
- PROVIDE 4" VALVED STUB-OUT SIMILAR TO 4" VALVED RISER FOR CH#1.

5. INSTALLATION AND COMMISSIONING OF (2) NEW CHILLERS

-FC, TYP. TO 12

ECCENTRIC REDUCER, TYP. TO 3

ARE TO COMPLETED BY OTHERS

TDV, TYP. TO 6 BFV ON RISER, TYP. TO 4

FUTURE PCHWP#3

PCHWP#2

PCHWP#1

PRESSURE GAUGE, TYP. TO 12 -SD, TYP. TO 6 -

- SCHWP#2

SCHWP#1

TEMPERATURE GAUGE, TYP. TO 12

SCHWP#3

BFV, TYP. TO 2 CHWS HEADER

- CHWS/R GASKETED BLIND FLANGED STUB-OUT FOR EMERGENCY CHILLER

BFV, TYP. TO 8

PRESSURE GAUGE, TYP. TO 4

NOTE 3 -

NOTE 1-

CHWR HEADER

NOTE 2

CHWS/R CASKETED BLIND FLANGED SUTB-OUT FOR EMERGENCY CHILLER

TEMPERATURE CAUGE,
TYP. TO 4

CH#1

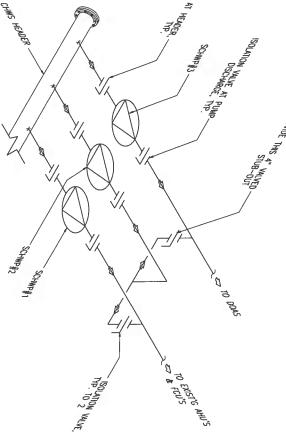
CH#2

CHWS HEADER SCHWP#2 SCHWP#1 200 00 000 2 3

2 SCHWP SCHEMATIC SHOWING ISOLATION VALVES

BRIEF DESCRIPTION OF WORK

- THIS PROJECT IS TO INSTALL A CHILLED WATER PLANT AT THE EXISTING ROOM & YARD OF EXISTING SKILLED NURSING FACILITY.
- EQUIPMENT WILL INCLUDE THREE SCHWPs, CHILLED WATER SUPPLY & RETURN HEADERS, CHILLED W AND ACCESSORIES. TWO PACKAGED AIR-COOLED CHILLER, THREE PI
- CHILLED WATER PIPING SYSTEMS WILL INCLUDE VALVED STUB-OUTS FOR RELATED ELECTRICAL AND CONCRETE WORK.



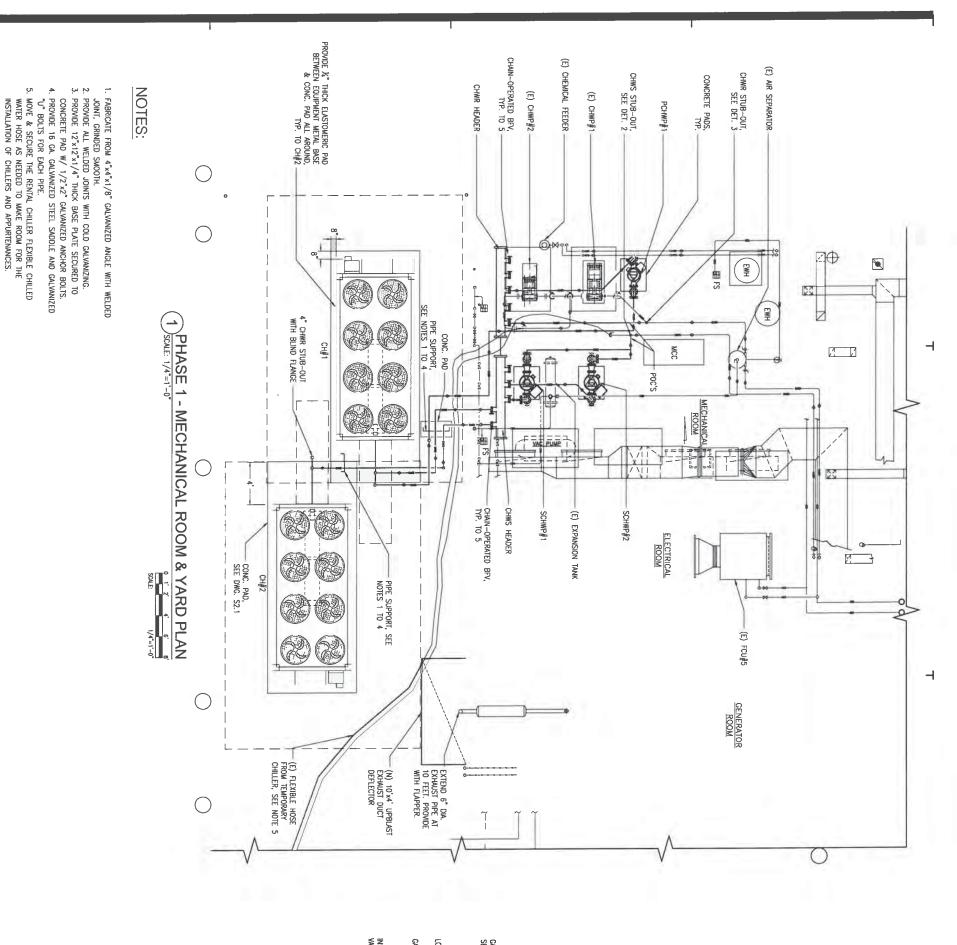
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KETED BLIND	لد نه	AX: (671)646-86	,com
		(MECHANICAL)	
MECHANICAL		OF LAND AND AND AND AND AND AND AND AND AND	Department of the second
PCHWPs, WATER PIPING		DATE: 11.03.2021	
DOASs.			
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	Pro	oject:	
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5	BA	BARRIGADA, GUAM	
1	Title: EQUIPA SUGGE	INCOME OF THE PROPERTY OF THE	
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1) CHILLED WATER PLANT SCHEMATIC DIAGRAM

- FC, TYP. TO 4

 \vdash



 \vdash

5) NOT TO SCALE

L DETAIL

M2.1

PHASE 1 - MECHANICAL ROOM & YARD PLAN, CHWS/R STUB-OUT DETAIL, CLEVIS PIPE HANGER DETAIL & NOTE:

Checked:

ASC

ASC SHOWN

10/27/2021

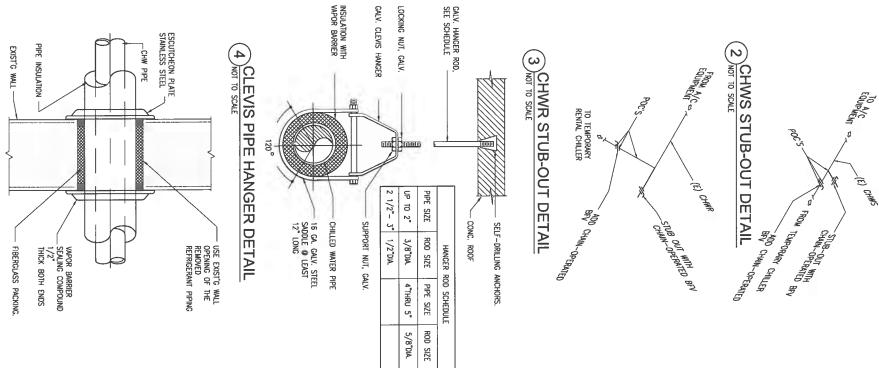
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Designed: EMC2

ACF CHILLERS
GMH SKILLED NURSING
FACILITY

BARRIGADA, GUAM

Project:



BY HE OR UNDER MY DIRECT SUPERVISION

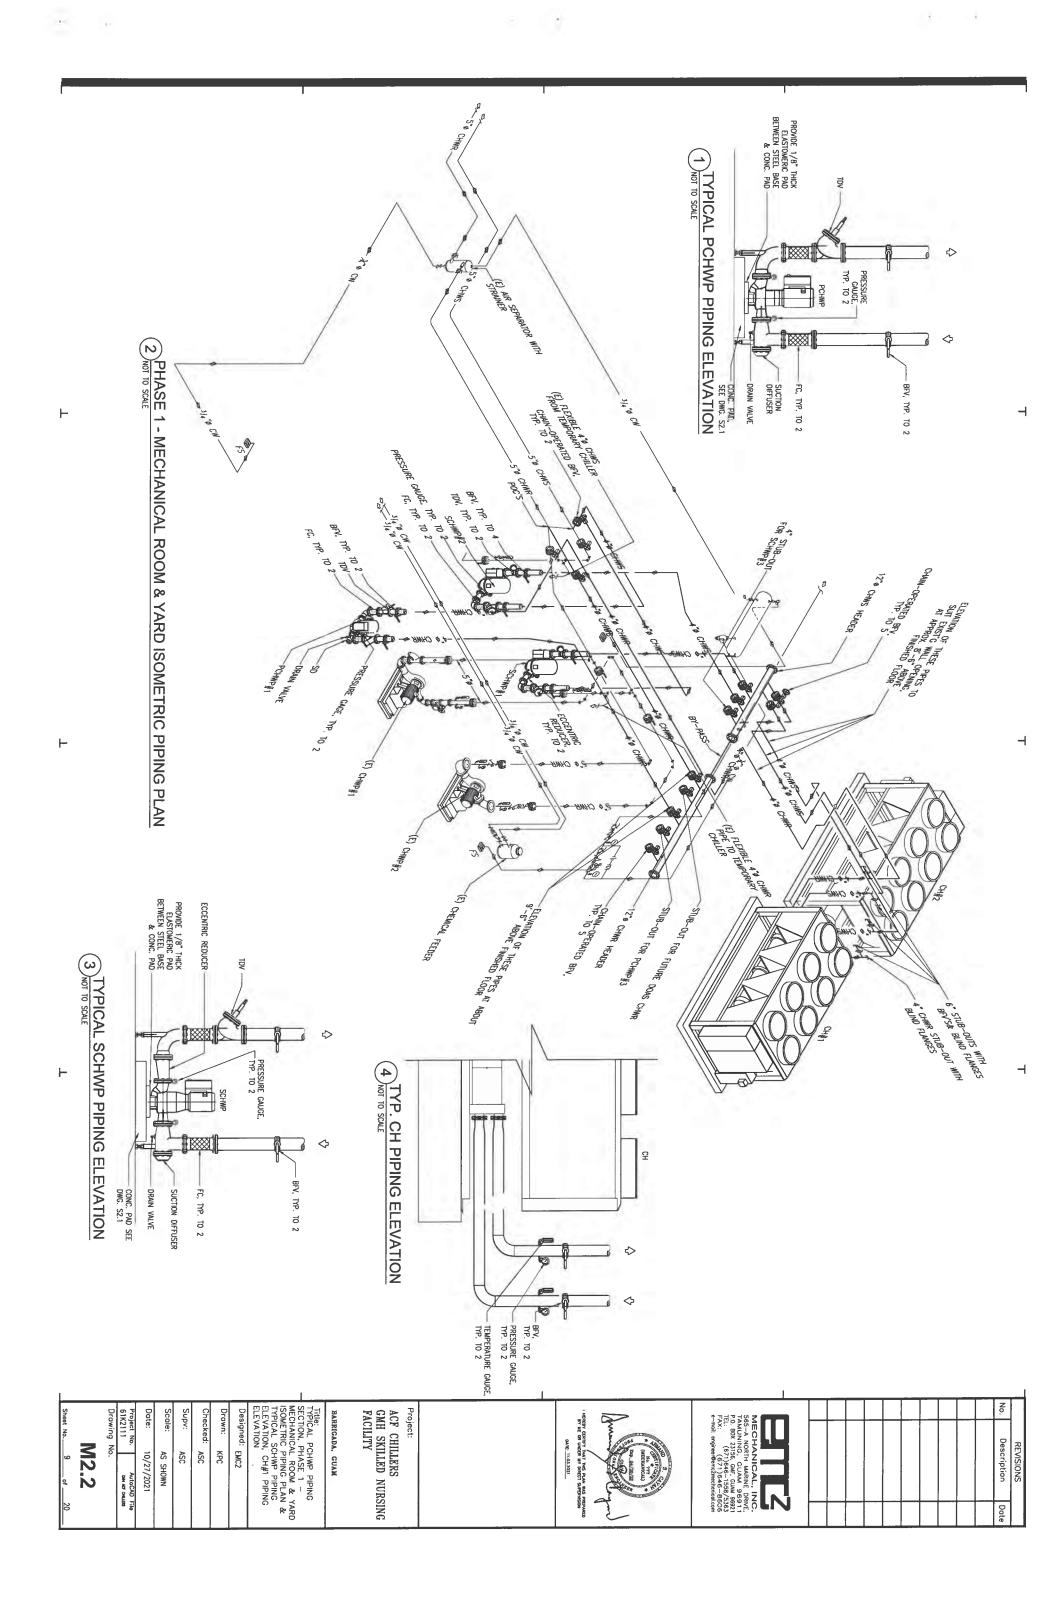
DATE: 11.03.2021

TAMUNING, GLAM, 96911
P.O. BOX 23156, GMF, GUAM 96921
P.O. BOX 23156, GMF, GUAM 95921
P.O. BOX

Description

Date

REVISIONS

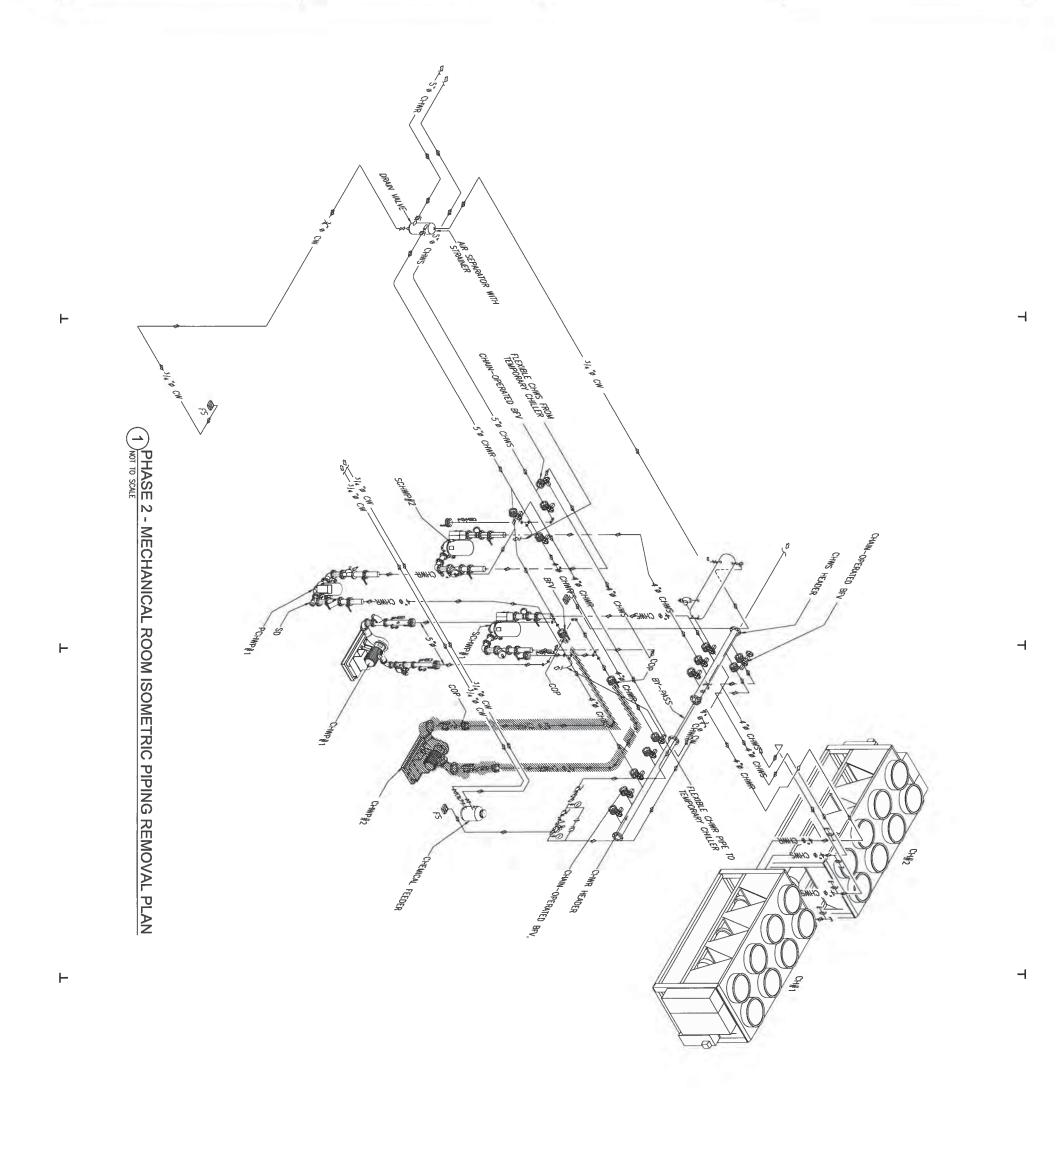


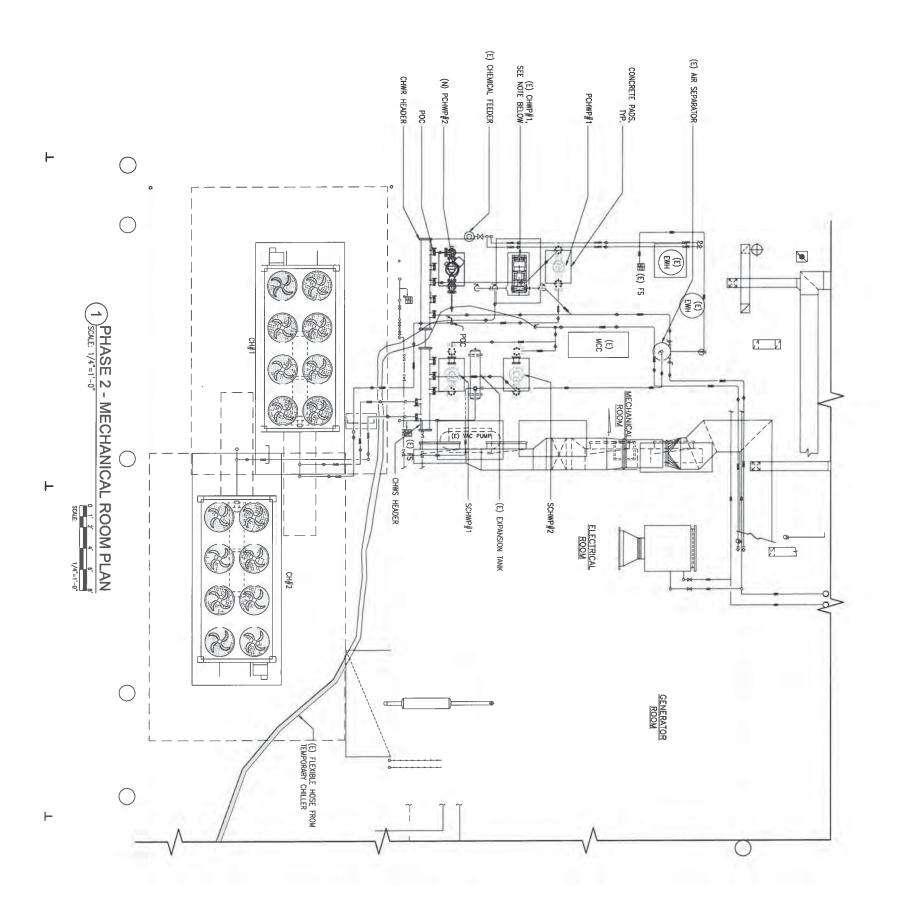
CHEMICAL FEEDER CHWR HEADER CHWP#1 0 \bigcirc EWH SS. 1) PHASE 2 - MECHANICAL ROOM REMOVAL PLAN MCC DG . — SCHWP#2 SCHWP#1 EXPANSION TANK CH#2 M 7 FLEXIBLE HOSE FROM TEMPORARY CHILLER

TEMOVE CHWP#2 & CONCRETE PAD.

KEYED NOTE:

MECHANICAL, INC. 565-A NORTH MARINE DRIVE, 566-A NORTH MARINE DRIVE, 667-300 CLUM 959-11 Froject: ACF CHILLERS GMH SKILLED NURSINI FROM REMOVAL PLAN & REPARAM Title: PHASE 2 - MECHANICAL FROM REMOVAL PLAN & REPARAM Title: Designed: EMC2 Drown: KPC Checked: ASC Supv: ASC Supv: ASC Supv: ASC Scole: 10/27/2021 Froject No. Drowing No. N3.1 Sheet No. 10 of 20			1		
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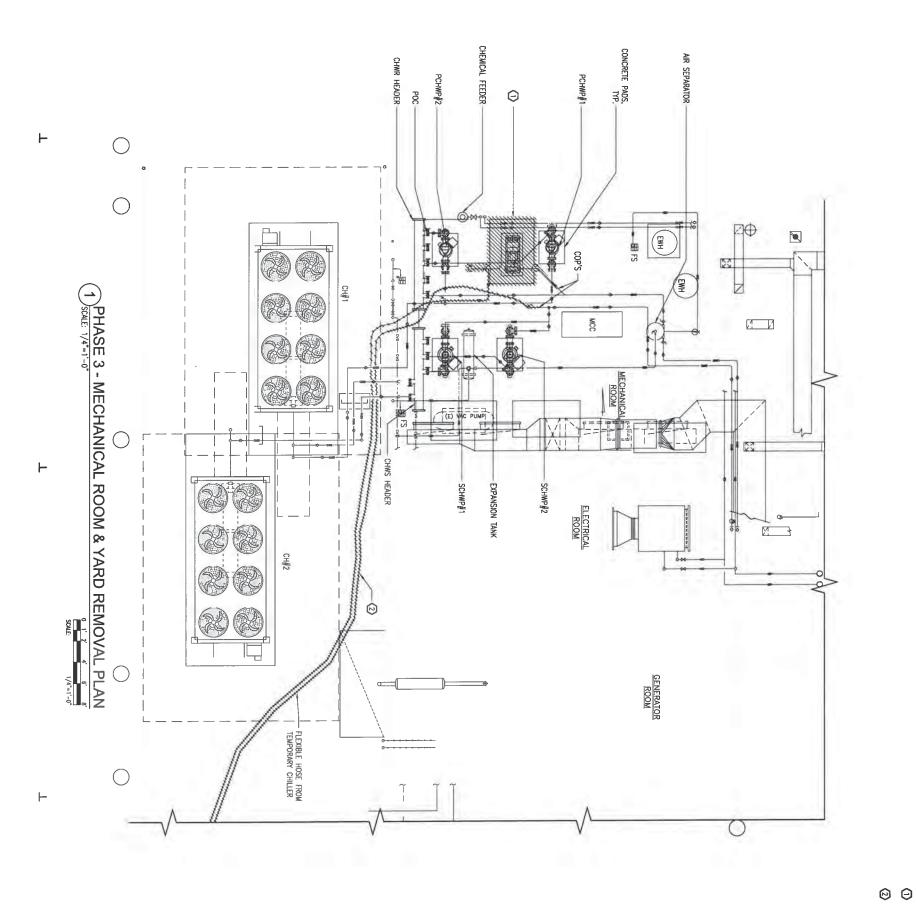




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LE) AIR SEPARATOR WITH 1) PHASE 2 - MECHANICAL ROOM ISOMETRIC PIPING PLAN (E) CHWP#1 CHWR HEADER

Project:
ACF CHILLERS
GMH SKILLED NURSING
FACILITY Checked: ASC Designed: EMC2 PHASE 2 - MECHANICAL ROOM ISOMETRIC PIPING PLAN MECHANICAL, INC.
565-A NORTH MARINE DRIVE,
TAMUNING, GLAM 96911
P.O. BOX 23156, G.H.; GLAM 96921
TEL: (671)646-1558/5353
FAX: (677)646-8666
e-mail: enginer@emc/methanical.com Sheet No. 13 of 20 BARRIGADA, GUAM REVISIONS Description DATE: 11.03.2021 M4.2 KPC 10/27/2021 ASC AS SHOWN AutoCAD File Date



KEYED NOTES:

				KEYED NOTES: REMOVE CHWP#1, CONCRETE PAD & EXISTING PIPING. REMOVE RENTAL CHILLER & ASSOCIATED PIPING.
Designed: EMC2 Drawn: KPC Checked: ASC Supv: ASC Supv: ASC Scale: AS SHOWN Date: 10/27/2021 Project No. AutoCAD File 61K2111 AutoCAD File 61K2111 AutoCAD File 51K2111 AutoCAD File	Project: ACF CHILLERS GMH SKILLED NURSING FACILITY BARRIGADA, GUAN Title: PHASE 3 - MECHANICAL ROOM & YARD REMOVAL PLAN & KEYED NOTES	COMPANY THE PLAN ME PROPERTY OF THE TAIL THE PROPERTY OF THE PLAN ME PROPERTY	MECHANICAL, INC. 555-A NORTH MARINE DRIVE. TAMUNING, GUAM 96911 P.O. BOX 23156, GHF. GUM 98921 TEL: (87)9649-559/5383 FAX: (67)9649-8806 9-moil: angines/Burn/Zmechanical.com	

1) NOT TO SCALE \vdash POC HEADER \vdash

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O File	URSING	NACON STATE OF STATE	Date

CONCRETE PAD, TYP. -GASKETED BLIND
FLANGES --(E) PCHWP#1-(E) PCHWP#2 PCHWP#3 -SCHWP#3 POC \bigcirc \bigcirc 1 # FS (EWH#2) Z CH#1 PHASE 3 - MECHANICAL ROOM & YARD PLAN

Scale: 1/4"=1"-0"

Scale: 1/4"=1"-0"

Scale: 1/4"=1"-0"

Scale: 1/4"=1"-0" MCC POC BFV & BLIND FLANGE 5"ø CHWS/CHWR -- (E) SCHWP#1 (E) SCHWP#2 M 7 CH#2 \bigcirc \bigcirc

No. Description Date

Description Date

Description Date

Description Date

Project:

ACF CHILLERS
GMH SKILLED NURSING
FACILITY

BARRICADA, GUAM

Title:

Phase 3 - MECHANICAL
Title:

Designed: MC2

Drawn: KPC

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Date: 10/27/2021

Project No.

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Sheet No. 116 of 20

(E) AIR SEPARATOR WITH -4 \vdash 1) PHASE 3 - MECHANICAL ROOM & YARD ISOMETRIC PIPING PLAN PRESSIRE CAUGE, THE, TO 2

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Descript

GENERAL NOTES

ELECTRICAL LAYOUT DRAWNGS ARE PARTIALLY DIAGRAMMATIC. REFER TO ARCHITECTURAL, STRUCTURAL, MECHANICAL AND HYAC FOR GUIDANCE ON DIMENSIONS, CELING HEGHETS, DOOR SWINGS, ROOM FINISHES, STRUCTURAL AND ARCHITECTURAL DETAILS, AND LOCATIONS OF PIPES AND STRUCTURAL STELL. HIS FALL THE ELECTRICAL SYSTEMS WITHOUT INTERFERING WITHOUT INTERFERING STRUCTURAL STELL, OR OTHER SYSTEMS. LOCATE LICHTING SYSTEMS SYMMETRICALLY IN PROPER RELATION TO FINISHED AREAS EXCEPT WHERE DMENSIONED ON THE DRAWNGS OR LOCATED ON REFLECTED CELING PLANS. COORDINATE WITH OTHER TRADES FOR PROPER INSTALLATION OF WORK AND FOR TIMELY EXECUTION OF CONSTRUCTION.

PURNISH ALL LABOR, EQUIPMENT, APPLIANCES, MATERIALS AND PERFORM OPERATIONS REQUIRED FOR COMPLETE INSTALLATION OF SYSTEMS SPECIFIED IN ACCORDANCE WITH DRAWNIOS, CODES, ORDINANCES AND TERMS AND CONDITIONS OF CONTRACT.

COMPLY WITH THE LATEST EDITION OF ALL APPLICABLE CODES, ORDINANCES AND REGULATIONS.

PROVIDE ADDITIONAL SUPPORTS FOR SWITCHES, STARTERS, RACEWAYS AND OTHER ELECTRICAL EQUIPMENT WHEREVER THE BUILDING STRUCTURE IS NOT SUITABLE FOR DIRECT MOUNTING. SYMBOLS IN THE LEGIND ARE APPLICABLE GENERALLY, FOR EXACT REQUIREMENTS, REFER TO THE SCHEDULES, LAYOUTS, AND DETAILS. THE APPEARANCE OF A PARTICULAR SYMBOL DOES NOT NECESSARILY IMPLY THAT THE ITEM IS INCLUDED IN THE CONTRACT.

VERIFY CEILING SUSPENSION SYSTEMS IN THE VARIOUS AREAS AND PROVIDE HE PROPER MOUNTING ACCESSIONES, TRIMS, ETC. TO SUIT THE PARTICULAR AREA. SUPPORT RACEWAYS WITH APPROVED THES OF WALL BRACKETS OR CEILING TRAFEZE HANGER. DO NOT SUSPEND FROM DROPPED CEILING, THE WREE OR 1-BAR. PROVIDE SAFETY WREES FOR EACH LIGHTING EXTURE IN NEW DROPPED CEILING, SO THAT IN THE EVENT OF CEILING FAILURE, NO PART OF THE FATURE WILL DROP MORE THAN 12" BELOW NORMAL CEILING HEIGHT.

PROVIDE SEAL FITTINGS IN CONDUITS THAT ENTER CONDITIONED AREAS FROM NON-CONDITIONED AREAS.

òo PROPERLY GROUND CONDUIT SYSTEM, OUTLETS, FIXTURES, ETC. IN ACCORDANCE WITH THE NATIONAL ELECTRICAL CODE, SECTION 250. PROVIDE ALL BONDING JUMPERS AND WIRE, GROUNDING BUSHINGS, CLAMPS, ETC. REQUIRED FOR COMPLETE GROUNDING. PROVIDE GREEN GROUND WIRE IN EACH RACEWAY.

CONNECT BRANCH CIRCUIT NEUTRAL TO RECEPTACLE TERMINAL BY MEANS OF A SHORT "PIGTAIL" PERMANENTLY SPLICED TO THE NEUTRAL.

9

ō PROVIDE 3/4" CONDUIT FROM EACH THERMOSTAT TO THE EQUIPMENT THAT IT CONTROLS. SEE MECHANICAL PLANS FOR THERMOSTAT LOCATIONS.

≓ ALL WRING SHALL BE COPPER. ALL POWER WRING #10 AND SMALLER SHALL BE SOLID. #8 AND LARGER MAY BE STRANDED. COLOR CODE ALL WRING BY SYSTEM. FOR 120/2008 YSTEMS, PHASE B SHALL BE BLACK, PHASE B SHALL BE RD AND PHASE C SHALL BE BLOW, PHASE A SHALL BE BROWN, PHASE B SHALL ORANGE AND PHASE C SHALL BE TELLOW.

SCOPE OF ELECTRICAL WORK DOES NOT AFFECT GPA, GPA'S SERVICE ENTRANCE WIRING, GPA'S TRANSFORMER OR GPA'S METER.

12.

LEGEND

AS SUBSCRIPT DENOTES "WEATHERPROOF"
GROUND FAULT CIRCUIT INTERRUPTER REVISION SYMBOL

HOME RUN TO PANEL OR CABINET
MACNETIC MOTOR STARTER
DISCONNECT SWTCH - UNFUSED
DISCONNECT SWTCH - FUSED
COMBINATION MOTOR STARTER - DISCONNECT

CIRCUIT BREAKER QUADRAPLEX CONVENIENCE OUTLET DUPLEX CONVENIENCE OUTLET MP FRAME

JUCTION BOX

CONTACTOR COIL
ROOM NUMBER
REFER TO NOTE INDICATED
HORSE POWER
EXHAUST FAN
NOT IN CONTRACT
CURRENT TRANSFORMER
EQUIPMENT CONNECTION CALLOUT MP TRIP

BRANCH CIRCUIT PANEL

TRANSFORMER
MOTOR CONNECTION
BRANCH CIRCUIT, I =HOT, |=NEUTRAL Î=SWITCHED
FLEXIBLE CONDUIT

USE MATERIALS TO MATCH EXISTING CONSTRUCTION UNLESS SPECIFED ELSEWHERE IN THESE CONTRACT DOCUMENTS. MATERIALS SHALL COMPLY TO LOCAL CODES AND UL AND SHALL BE PROPERLY APPLIED TO THEIR INTENDED FUNCTION.

EXISTING SYSTEM NOTES

No.

REVISIONS Description

Date

RELOCATE ALL EXISTING EQUIPMENT AND DEVICES REQUIRED TO ACCOMMODATE THE NEW CONSTRUCTION AS SHOWN ON THE DRAWNICS. EXISTING WORK WHICH, IN THE OPINION OF THE ARCHITECT, IS TO REMAIN, SHALL BE RELOCATED IF NECESSARY.

EXISTING ELECTRICAL EQUIPMENT, WIRING AND INSTALLATION WHICH ARE TO BE REMOVED, SHALL BE REMOVED AS A PART OF THIS CONTRACT AND SHALL BE DISPOSED OF PROPERLY. VERTY WHICH MATERIALS ARE CONSIDERED SALVAGE AND THESE SHALL BE TURNED OVER TO THE OWNER FOR HIS USE.

EXTEND EXISTING CIRCUITS SERVING EQUIPMENT TO BE RELOCATED, MATCHING EXISTING WIRE AND CONDUIT SIZE.

RE-USE EXISTING RACEWAYS WHERE POSSIBLE AND WHERE PERMITTED BY CODE. RE-WORK EXISTING RACEWAYS WHERE REQUIRED. SECURE ALL REUSED RACEWAYS WHICH ARE LODSE OR NOT PROPERLY CONNECTED. INSPECT ALL WIRE CONNECTIONS AND RETIGHTEN WHERE REQUIRED.

CHECK CONTINUITY OF THE EXISTING GROUNDING AND RECONNECT AND RETIGHTEN ALL CONNECTIONS TO ESTABLISH A SAFE AND CONTINUOUS GROUNDING SYSTEM THROUGHOUT THE SYSTEM.

WIXON & ASSOC.
CONSULTING ENGINEERING
BZS, WARK DR
TAUNING, CLAM 98913
TEL (671) 646-1033
WARKON-ASSOCATES.COM

RESY CERTIFY THAT THIS PLAN WAS PREPARED BY ME OR UNDER MY DIRECT SUPERWISON

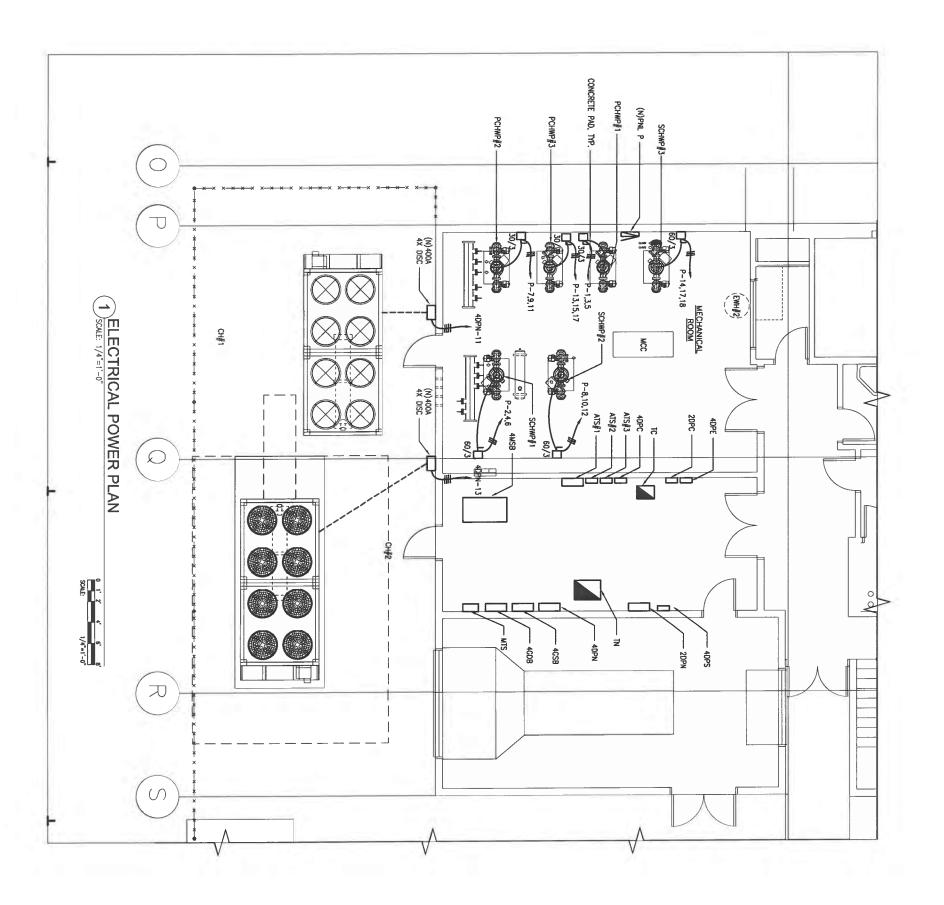
Project:

ACF CHILLERS
GMH SKILLED NURSING
FACILITY

NOTES, LEGEND BARRIGADA, GUAM

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